LOW POINT

L.P.

LONG LEG HORIZONTAL

LONG LEG VERTICAL

WIDE

WITH

W/0

WDW.

WD. WOOD

WITHOUT

WINDOW

LOUVER MARK

NUMBERED NOTE MARK

INDEX TO DRAWINGS

INDEX INDEX TO DWGS, DESIGN CRITERIA, GENERAL NOTES

A1.01 FLOOR PLAN - BRYSON ELEMENTARY SCHOOL

SYMBOLS / LEGEND

ROOM NUMBER MARK

DOOR NUMBER MARK

STOREFRONT MARK


PARTITION TYPE MARK

GLAZED OPENING MARK

DATUM ELEVATION MARK

SECTION MARK

PERSONAL PROPERTY OF THE STATE	VARO VARO 185
ISSUED: M	
REV	'ISIC
Director LGV Designer	D R Q
DSN Proj. Arch. PA	Q
PROJ 180	
SHE	
l IN	IDE

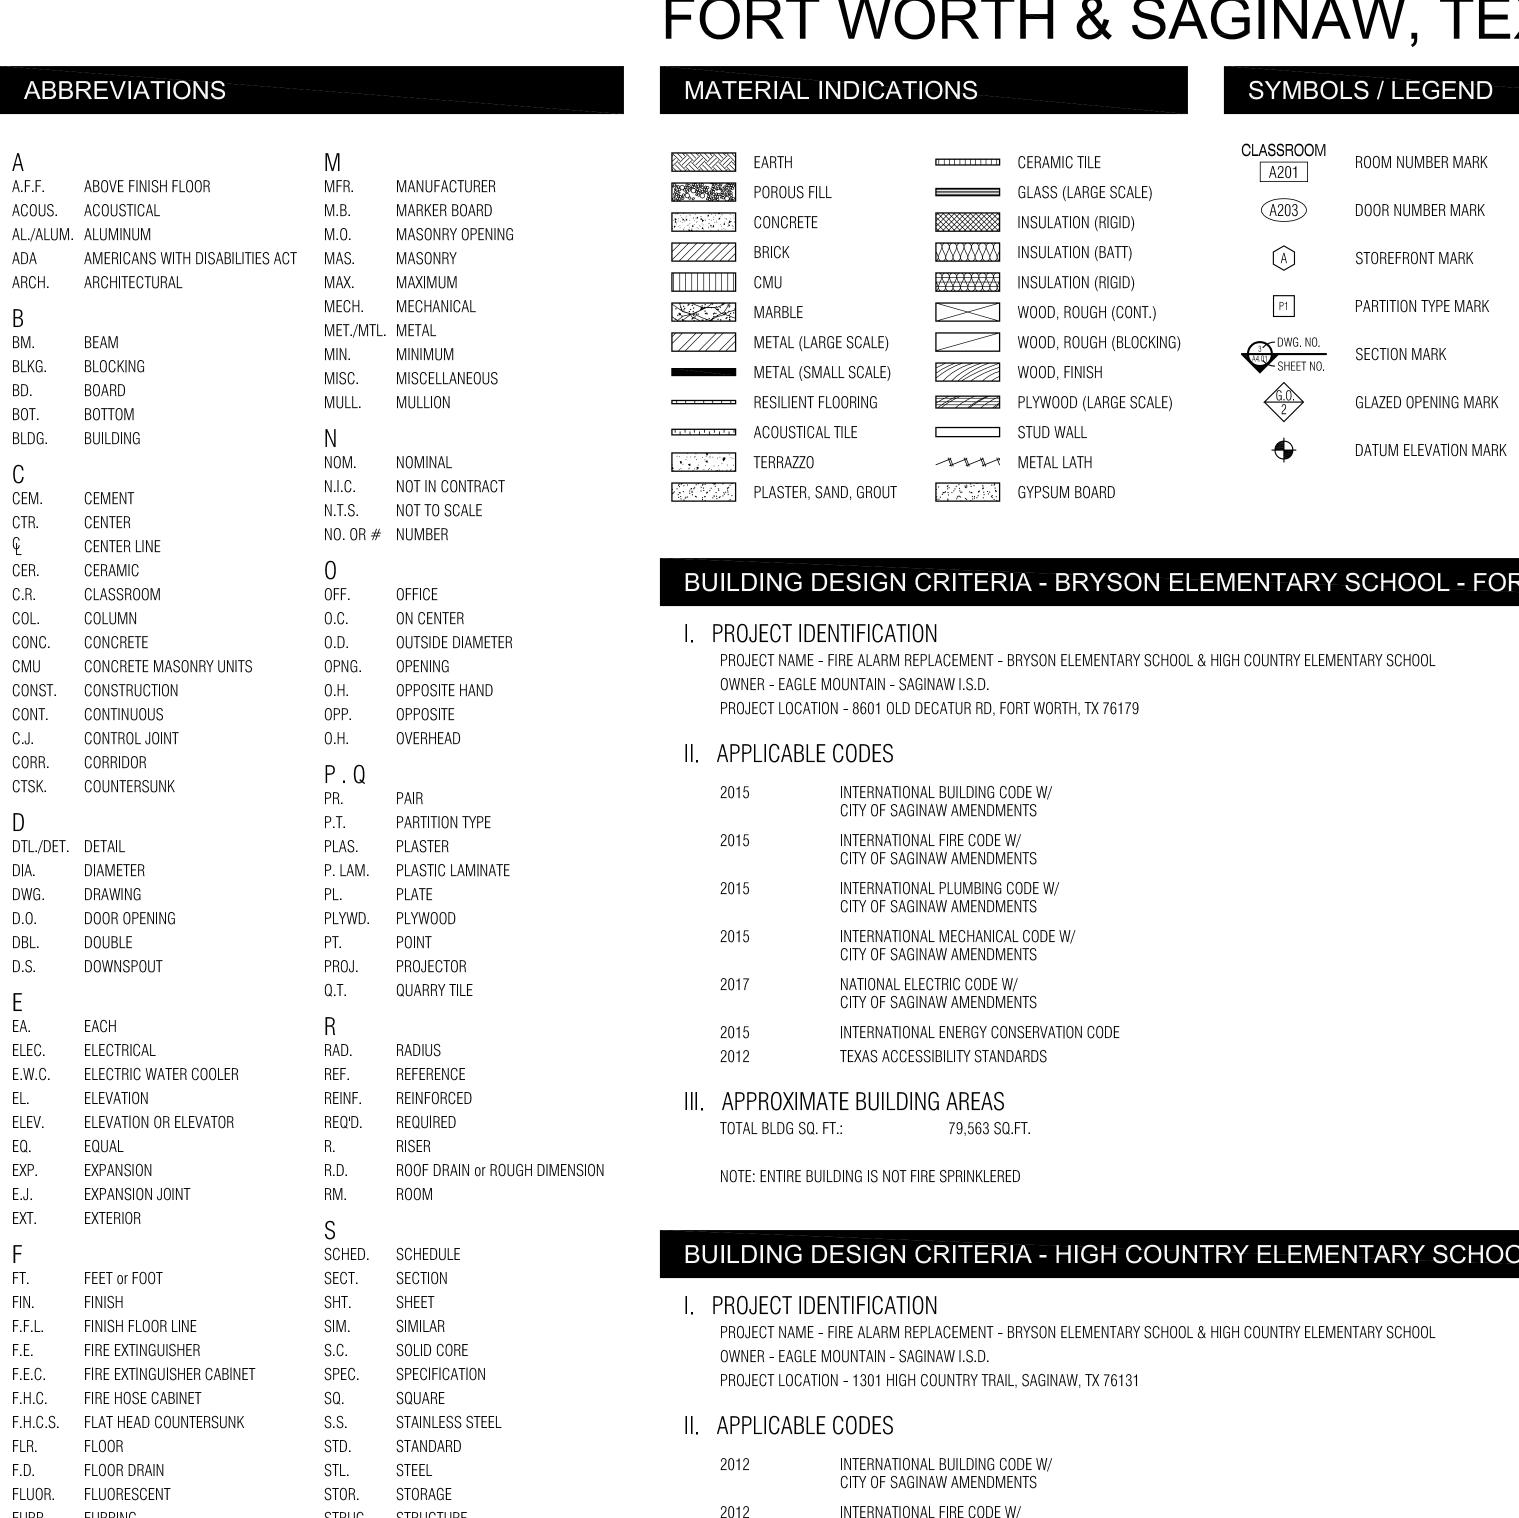

0.0.		0.11.	OVERNIEAD		APPI ICAF	BLE CODES
CORR.	CORRIDOR	P.Q		""	7 (1 1 E10) (E	
CTSK.	COUNTERSUNK	PR.	PAIR		2015	INTERNATIONAL BUILDING CODE W/
D		P.T.	PARTITION TYPE			CITY OF SAGINAW AMENDMENTS
DTL./DET.	DETAIL	PLAS.	PLASTER		2015	INTERNATIONAL FIRE CODE W/
						CITY OF SAGINAW AMENDMENTS
DIA.	DIAMETER	P. LAM.	PLASTIC LAMINATE		2015	INTERNATIONAL PLUMBING CODE W/
DWG.	DRAWING	PL.	PLATE		2013	CITY OF SAGINAW AMENDMENTS
D.0.	DOOR OPENING	PLYWD.	PLYW00D		0015	
DBL.	DOUBLE	PT.	POINT		2015	INTERNATIONAL MECHANICAL CODE W/ CITY OF SAGINAW AMENDMENTS
D.S.	DOWNSPOUT	PROJ.	PROJECTOR			
		Q.T.	QUARRY TILE		2017	NATIONAL ELECTRIC CODE W/
	FAOLI	D				CITY OF SAGINAW AMENDMENTS
EA.	EACH	R	DARWIG		2015	INTERNATIONAL ENERGY CONSERVATION CODE
ELEC.	ELECTRICAL	RAD.	RADIUS		2012	TEXAS ACCESSIBILITY STANDARDS
E.W.C.	ELECTRIC WATER COOLER	REF.	REFERENCE			
EL.	ELEVATION	REINF.	REINFORCED	.	APPROXI	MATE BUILDING AREAS
ELEV.	ELEVATION OR ELEVATOR	REQ'D.	REQUIRED		TOTAL BLDG	SQ. FT.: 79,563 SQ.FT.
EQ.	EQUAL	R.	RISER			
EXP.	EXPANSION	R.D.	ROOF DRAIN or ROUGH DIMENSION		NOTE: ENTIRE	BUILDING IS NOT FIRE SPRINKLERED
E.J.	EXPANSION JOINT	RM.	ROOM		NOTE: ENTINE	L BOILDING TO NOT TIME OF THINKLEFIED
EXT.	EXTERIOR	0				
		5				
F		SCHED.	SCHEDULE	Вί	JILDING	DESIGN CRITERIA - HIGH COUNTRY ELEMENTARY SCHOOL - SAGINAW, TX
FT.	FEET or FOOT	SECT.	SECTION			
FIN.	FINISH	SHT.	SHEET		PROJECT	IDENTIFICATION
F.F.L.	FINISH FLOOR LINE	SIM.	SIMILAR	•		ME - FIRE ALARM REPLACEMENT - BRYSON ELEMENTARY SCHOOL & HIGH COUNTRY ELEMENTARY SCHOOL
F.E.	FIRE EXTINGUISHER	S.C.	SOLID CORE			GLE MOUNTAIN - SAGINAW I.S.D.
F.E.C.	FIRE EXTINGUISHER CABINET	SPEC.	SPECIFICATION			CATION - 1301 HIGH COUNTRY TRAIL, SAGINAW, TX 76131
F.H.C.	FIRE HOSE CABINET	SQ.	SQUARE		FNOJEGI LOC	GATION - 1301 FIRST COUNTRY TRAIL, SAGINAW, 17 70131
F.H.C.S.	FLAT HEAD COUNTERSUNK	S.S.	STAINLESS STEEL	Ш	A DDI ICAE	BLE CODES
FLR.	FLOOR	STD.	STANDARD	11.	AFFLIGAL	DLE GODES
F.D.	FLOOR DRAIN	STL.	STEEL		2012	INTERNATIONAL BUILDING CODE W/
FLUOR.	FLUORESCENT	STOR.	STORAGE			CITY OF SAGINAW AMENDMENTS
					2012	INTERNATIONAL FIRE CODE W/
FURR.	FURRING	STRUC.	STRUCTURE		2012	CITY OF SAGINAW AMENDMENTS
G.H		SUSP.	SUSPENDED		2012	INTERNATIONAL PLUMBING CODE W/
GALV.	GALVANIZED	Т			2012	CITY OF SAGINAW AMENDMENTS
GA.	GAUGE	T.B.	TACKB0ARD		0040	
G.C.	GENERAL CONTRACTOR	T.W.	TACK WALL		2012	INTERNATIONAL MECHANICAL CODE W/ CITY OF SAGINAW AMENDMENTS
G.O.	GLAZED OPENING	TEL.	TELEPHONE			
			TERRAZZO		2011	NATIONAL ELECTRIC CODE W/
GYP.	GYPSUM	TERR.				CITY OF SAGINAW AMENDMENTS
GND.	GROUND	THK.	THICK		2015	INTERNATIONAL ENERGY CONSERVATION CODE
HC.	HANDICAPPED	Ι.	TREAD		2012	TEXAS ACCESSIBILITY STANDARDS
HT.	HEIGHT	T.C.	TOP OF CURB OR TEACHERS CABINET			
H.	HIGH	T.O.J.	TOP OF JOIST	.	APPROXI	MATE BUILDING AREAS
H.P.	HIGH POINT	T.O.S.	TOP OF STEEL		TOTAL BLDG	SQ. FT.: 80,857 SQ.FT.
H.M.	HOLLOW METAL	T.O.W.	TOP OF WALL			
HORIZ.	HORIZONTAL	TYP.	TYPICAL		NOTE: ENTIRE	BUILDING IS FIRE SPRINKLERED
H.B. / HB	HORIZONTAL BLINDS	1.1			NOTE: ENTINE	L BOILDING TO THE OF THINKLE HEB
HR.	HOUR	U				
		U.L.	UNDERWRITERS LABORATORIES	G	FNFRAI	NOTES
I . J . K		U.N.O.	UNLESS NOTED OTHERWISE			
I.D.	INSIDE DIAMETER	\/		1. V	/ERIFY AND DOCUN	MENT EXISTING DIMENSIONS & CONDITIONS AT THE SITE BEFORE BEGINNING CONSTRUCTION. NOTIFY THE ARCHITECT OF CONFLICTS OR VARIATIONS PRIOR TO COMMENCEMENT OF CONSTRUCTION.
INSUL.	INSULATION	V \/EDT	VEDTICAL			RD SHALL BE TYPE "X" FIRECODE.
INT.	INTERIOR	VERT.	VERTICAL			S REQUIRED AND DIRECTED OVER OPENINGS IN WALLS WHERE MECHANICAL EQUIPMENT PENETRATES WALLS.
JAN.	JANITOR	VEST.	VESTIBULE		AT DRYWALL WALL ANCHORAGE OF W <i>A</i>	CONSTRUCTION WHICH EXTENDS ABOVE CEILING, PROVIDE LIGHT GAUGE FRAMING AND BRACING AT 4'-0" O.C., TYPICAL, TO STRUCTURE ABOVE IN ORDER TO PROVIDE SECURE PERMANENT, AND RIGID
JT.	JOINT	V.C.T.	VINYL COMPOSITION TILE			G DETAILS; SUSPENSIONS, BRACING, BLOCKING, ETC., SHOWN IS SCHEMATIC REPRESENTATION ONLY. PROVIDE SECURE PERMANENT ANCHORAGE AT FURRINGS IN ACCORDANCE WITH RECOMMENDED
JST.	JOIST	VWC	VINYL WALL COVERING	D	RYWALL INSTALLA	ATION PRACTICE, TYPICAL.
KIT.	KITCHEN	W				1B AND TRUE WITH 90 DEGREE CORNERS, UNLESS NOTED OTHERWISE. ND BOILER ROOMS. SEAL PARTITIONS TIGHTLY AROUND STRUCTURAL. MECHANICAL. AND ELECTRICAL PENETRATIONS.
13111	MIDILI	WSCT.	WAINSCOT			ND BOILER ROOMS, SEAL PARTITIONS TIGHTLY AROUND STRUCTURAL, MECHANICAL, AND ELECTRICAL PENETRATIONS. 5. LINTELS, CURBS, AND FLASHING, THROUGH FLOORS, WALLS AND ROOF TO ACCOMMODATE MECH. AND ELEC. FACILITIES.
L						F CONTROL JOINTS IN FACE BRICK, CMU, GYPSUM BOARD TO THE ARCHITECT PRIOR TO CONSTRUCTION.
LAM.	LAMINATE	W.C.	WATER CLOSET	10. F	LOOR PLAN DIMEN	ISIONS ARE TO FACE OF CMU OR STUD UNLESS NOTED OTHERWISE.

15. AT ALL INTERIOR AND EXTERIOR MASONRY CORNERS, PROVIDE A 3/8" BUTT CONTROL JOINT.

17. PROVIDE SEALANT AND FIRESAFING AT ALL FLOOR PENETRATIONS AND EXPANSION JOINTS.

14. SEAL PARTITION TIGHTLY AROUND ALL STRUCTURAL, MECHANICAL, PLUMBING AND ELECTRICAL PENETRATIONS WITH SAFING.

20. IN CASE OF DISCREPANCIES IN THE CONSTRUCTION DOCUMENTS. THE GREATER QUANTITY OR QUALITY SHALL BE PROVIDED.

13. ALL CMU WALLS SHALL HAVE 8" STARTER COURSES UNLESS NOTED OTHERWISE.

16. USE BULLNOSE TILE AT OUTSIDE CORNERS AND TOP OF WAINSCOT AT CERAMIC TILE.

12. PROVIDE 1" BULLNOSE AT ALL EXPOSED VERTICAL EDGES OF CMU.

11. EXTREME CARE SHALL BE TAKEN TO AVOID DAMAGE TO EXISTING TREES AND SHRUBS, CONTRACTOR SHALL PROVIDE PROTECTIVE BARRIERS AROUND THOSE IN PROXIMITY TO THE WORK.

19. AT GYPSUM WALLBOARD AND PLASTER WORK USE CORNER BEADS, CASING BEADS AND METAL ACCESSORIES AS REQUIRED TO PROVIDE FINISH SURFACE TERMINATIONS.

21. THE USE OF 3 5/8" CMU FOR INTERIOR PARTITIONS IS NOT PERMITTED EXCEPT FOR USE IN CHASES. FREESTANDING 3 5/8" CMU PARTITIONS ARE NOT ALLOWED.

18. PROVIDE MINIMUM 2"X6" F.R. WOOD BLOCKING BETWEEN METAL STUDS IN NEW PARTITIONS AT MOUNTING LOCATIONS FOR ACCESSORIES, HANDRAIL CASEWORK, MARKER BOARDS, FOLDING PARTITIONS, ETC.


N ⊕B	NORTH ARROW HORIZONTAL BLINDS	A1.01 A1.61 A2.01 A2.61	REFLECTED CEILING PLAN - BRYSON ELEMENTARY SCHOOL REFLECTED CEILING PLAN - BRYSON ELEMENTARY FLOOR PLAN - HIGH COUNTRY ELEMENTARY SCH REFLECTED CEILING PLAN - HIGH COUNTRY ELEM	100L	
DWG. NO. 3/A8.01 SHEET NO.	ELEVATION MARK		FIRE ALARM		
DWG. NO. 6/A4.05 SHEET NO.	SECTION DETAIL MARK	FA1.01 FA2.01	FLOOR PLAN - FIRE ALARM - BRYSON ELEMENTA FLOOR PLAN - FIRE ALARM - HIGH COUNTRY ELE		
AC	ACCESS CONTROL MARK				
RT WORTH, T	X		XAS ACCESSIBILITY STA	NDARDS	
		PROV	ISIONS FOR ADULTS AND CHILDREN	ADULTS AGES 13 & ABOVE	CHILDREN AGES 12 & UNDER
			RANGES ONTAL OR SIDE APPROACH	48" MAX 15" MIN.	16" MIN 44" MAX.
			S AND STAIRS (HANDRAILS) P OF HANDRAIL GRIPPING SURFACE	34" - 38"	34" - 38"
			NG FOUNTAINS AND WATER COOLERS ONTAL APPROACH SPOUT HEIGHT (TO OUTLET)	36" MAX.	USE SIDE APPROACH
		SIE	KNEE CLEARANCE DE APPROACH	27" MIN.	OSE SIDE ALL HOAGH
			SPOUT HEIGHT (TO OUTLET) KNEE CLEARANCE	USE FRONT APPROACH	30" MAX. NOT REQUIRED
			CLOSETS NTERLINE TO WALL AT WHEELCHAIR ACCESSIBLE	16" - 18"	12" - 18"
			NTERLINE TO WALL AT AMBULATORY STALL	17" - 19"	17" - 19"
			P OF SEAT AB BARS	17" - 19" 33" - 36"	11" - 17" 18" - 27"
			SPENSER HEIGHT (MOUNT AT 7"-9" FROM CENTERLINE OF DISPENSER IN FRONT OF W.C.)	15" - 48"	14" - 19"
		FLU	JSH CONTROLS	36" MAX.	36" MAX.
DL - SAGINAW	, TX	URINAL	S		
	·	RIN	OF BASIN	17" MAX.	16" MAX.*
		FLI	JSH CONTROLS	48" MAX.	44" MAX.
			DRIES AND SINKS		
			1 OR COUNTER SURFACE	34" MAX.	31" MAX.
			EE CLEARANCE (LAVATORIES) EE CLEARANCE (SINKS)	27" MIN. 27" MIN.	24" MIN. 24" MIN.
			FAUCETS FROM FRONT EDGE	20" MAX.*	18" MAX.*
		MIRRO			
			TOP OF REFLECTIVE SURFACE	74" MIN.	74" MIN.
			BOTTOM OF REFLECTED SURFACE AT SINKS & LAV BOTTOM OR REFLECTED SURFACE	'S 40" MAX. 35" MAX.	35" MAX.* 35" MAX.*
			OLS AND OPERATING MECHANISM		
		HIG	GHEST OPERABLE PART FRONTAL AND SIDE APPROACH	48" MAX.	44" MAX.
		TELEPH			
		HIC	SHEST OPERABLE PART FRONTAL AND SIDE APPROACH	48" MAX.	44" MAX.
		FIXED (OR BUILT-IN SEATING, TABLES, & WORK STATIONS		
			IGHT OF TABLES OR COUNTERS EE CLEARANCES	26" - 30" 24" MIN.	26" - 30" 24" MIN.
		DRESS	ING & FITTING ROOMS		
TIONS PRIOR TO COMMENCEMEN	IT OF CONSTRUCTION.	TO	P OF BENCH (20"-24"D X 42"L MIN) CK SUPPORT 18"H MIN. OR MOUNT TO WALL	17" - 19"	11" - 17" *
		F005 (

FOOD SERVICE LINES

TOP OF TRAY SLIDE

* NOTE: DIMENSION FOR SPECIFIC AGE GROUP IS NOT LISTED IN 2012 TAS

28" - 34"

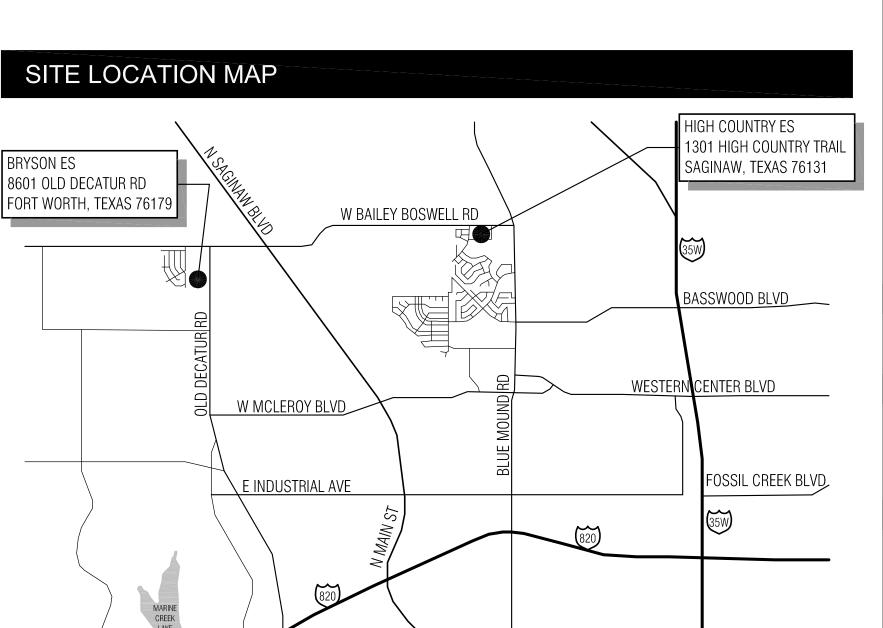

INDEX

SHEET NO.

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LGV
Designer
DSN
Proj. Arch.
PA Quality Control

> PROJECT NO. 1803.00

SHEET TITLE FLOOR PLAN

BRYSON ES

SHEET NO.

A1.01

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- REMOVE FIRE ALARM PULL DOWNS/SPEAKERS/STROBES. PATCH AND REPAIR WALL AS REQUIRED AND (W1) PREP FOR PAINT TO MATCH EXISTING. WHERE IN TILE, PREP FOR NEW TILE TO MATCH EXISTING FROM
- $\stackrel{\text{W2}}{\text{EXISTING}}$ REPLACE FIRE ALARM ANNUNCIATOR. PATCH AND REPAIR WALL AS REQUIRED AND PAINT TO MATCH EXISTING.
- REMOVE FIRE ALARM PULL DOWNS/SPEAKERS/STROBES IN MASONRY WALL. PROVIDE METAL FACE PLATE AND PAINT TO MATCH EXISTING.

- W5) REFERENCE MEP DRAWINGS FOR WORK @ EXISTING HOLD OPENS.
- NEW FIRE ALARM DEVICE. PREPARE EXTERIOR WALL FOR INSTALLATION. ENSURE GAPS ARE SEALED UPON COMPLETION OF INSTALLATION.
- DETERMINE ITEMS TO BE SALVAGED AND RETURNED TO OWNER. RELOCATE FIRE ALARM CONTROL PANEL WHERE SHOWN ON PLANS. PATCH AND PAINT EXISTING PARTITION. MATCH EXISTING FINISHES. 4. CONTRACTOR SHALL PROTECT ITEMS TO REMAIN FROM DAMAGE DURING DEMOLITION
 - REFER TO FIRE ALARM DEMOLITION PLANS FOR ADDITIONAL INFORMATION. 6. CONTRACTOR SHALL REPAIR @ NO COST TO THE OWNER ANY DAMAGES THEY INCUR ON
 - THE EXISTING BUILDING AND SITE AS A RESULT OF THEIR ACTIVITIES NOT SCHEDULED FOR ALTERATION.

GENERAL NOTES

IMPRACTICAL TO INDICATE OR NOTE EVERY ITEM OF DEMOLITION. ANY ITEMS SHOWN DASHED ARE TO BE REMOVED TO MAKE WAY FOR NEW CONSTRUCTION, UNLESS NOTED

DRAWINGS SHOW THE GENERAL EXTENT OF DEMOLITION WORK, HOWEVER IT IS

EXISTING MATERIALS CONTAINING ASBESTOS TO BE REMOVED UNDER SEPARATE CONTRACT PRIOR TO CONSTRUCTION BY OWNER'S ASBESTOS ABATEMENT CONTRACTOR.

CONTRACTOR SHALL CONTACT THE OWNER PRIOR TO THE START OF DEMOLITION TO

7. UNLESS OTHERWISE NOTED, NUMBERED NOTE 'W1' APPLIES TO ALL AREAS.



FLOOR PLAN - BRYSON ELEMENTARY SCHOOL SCALE: 1/16"=1"-0"

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REFLECTED CEILING PLAN LEGEND

EXISTING 1 HOUR FIRE WALL - ANY NEW PENETRATIONS

SHALL BE REPAIRED TO MAINTAIN RATING OF PARTITION


EXISTING 2'x2' GRID W/ LAY-IN ACOUSTIC CEILING TILE

PROJECT NO. 1803.00

BRYSON ES

SHEET NO.

A1.61

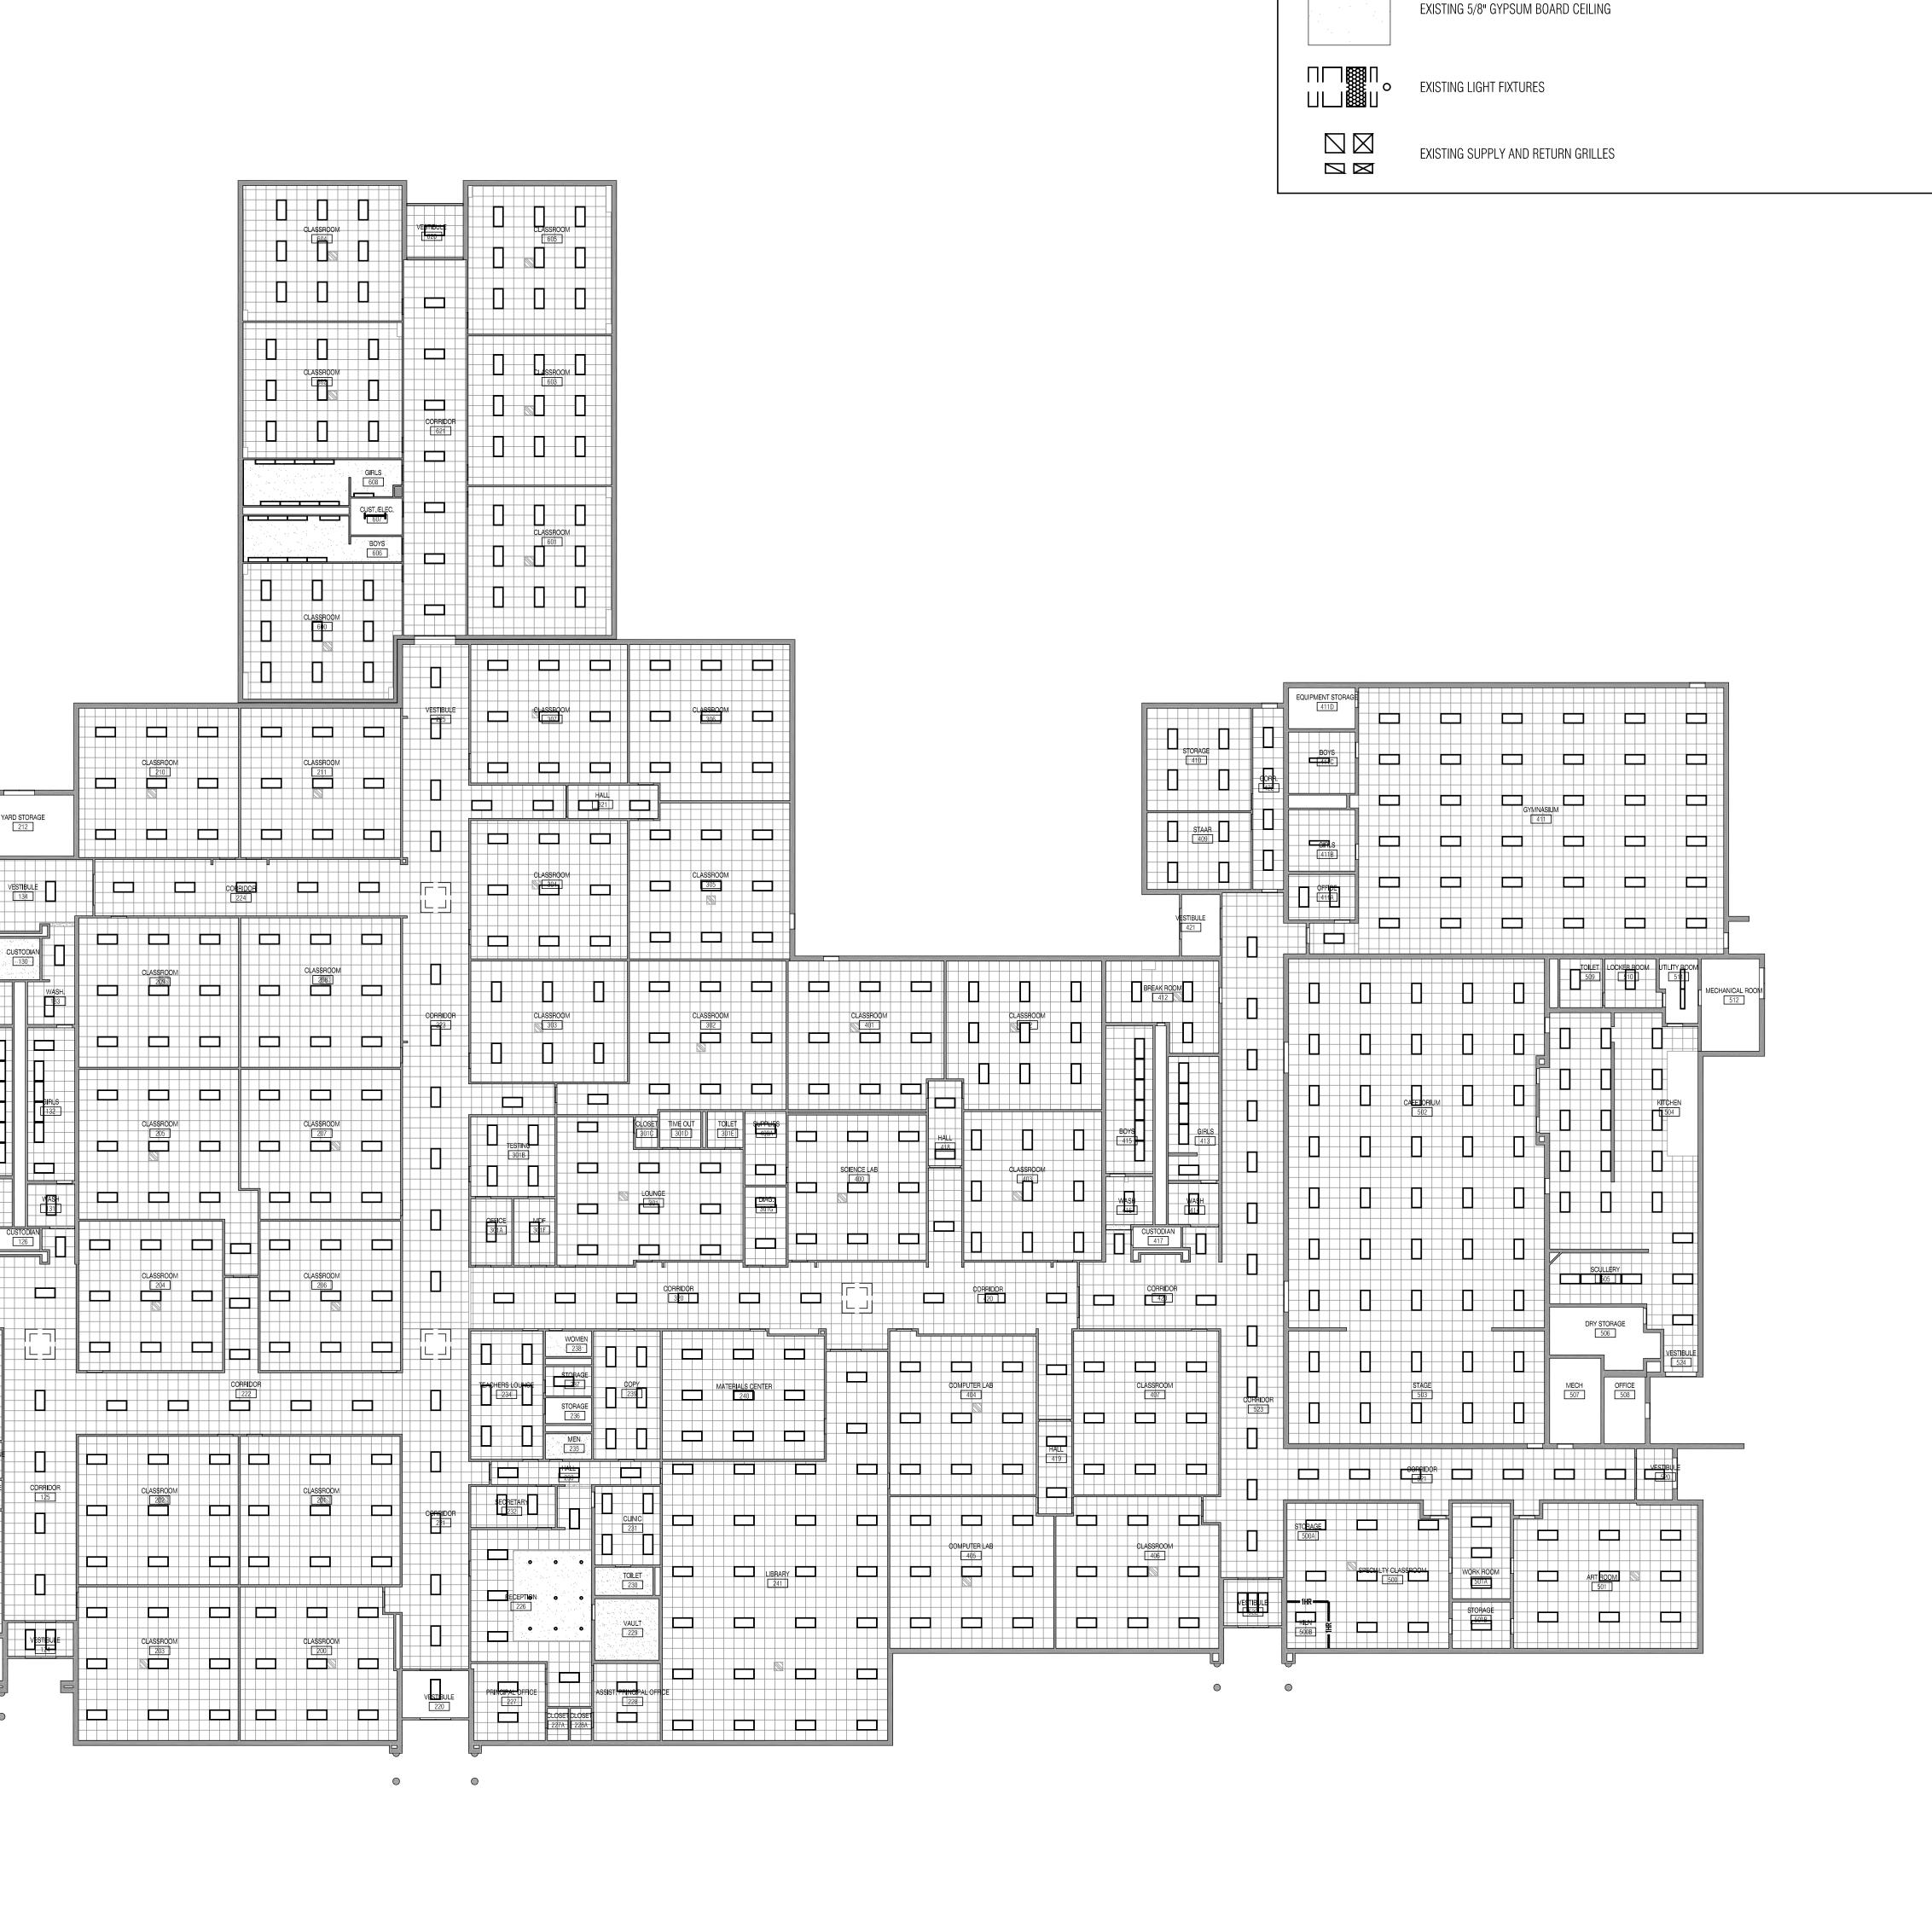

NUMBERED NOTES

1. REMOVE AND SALVAGE EXISTING CEILING TILE AS REQUIRED FOR INSTALLATION OF FIRE


DEVICES. PAINT TO MATCH EXISTING. REF. MEP DRAWINGS FOR ADDITIONAL

DRAWINGS FOR ADDITIONAL INFORMATION.

INFORMATION.

ALARM DEVICES. EXISTING GRID TO REMAIN. INSTALL NEW CEILING TILE WHERE EXISTING TILE IS DAMAGED BY WORK PREFORMED AS REQUIRED; MATCH EXISTING. REF. MEP

CUT & PATCH EXISTING GYP BD CEILING AS REQUIRED FOR INSTALLATION OF FIRE ALARM

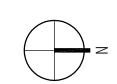

REFLECTED CEILING PLAN - BRYSON ELEMENTARY SCHOOL

SCALE: 1/16"=1'-0"

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Designer
DSN
Proj. Arch. **Quality Control**

PROJECT NO.

1803.00

SHEET TITLE

HIGH POINT ES

SHEET NO.

A2.01



- REMOVE FIRE ALARM PULL DOWNS/SPEAKERS/STROBES. PATCH AND REPAIR WALL AS REQUIRED AND W1) PREP FOR PAINT TO MATCH EXISTING. WHERE IN TILE, PREP FOR NEW TILE TO MATCH EXISTING FROM
- REPLACE FIRE ALARM ANNUNCIATOR. PATCH AND REPAIR WALL AS REQUIRED AND PAINT TO MATCH EXISTING.
- REMOVE FIRE ALARM PULL DOWNS/SPEAKERS/STROBES IN MASONRY WALL. PROVIDE METAL FACE PLATE AND PAINT TO MATCH EXISTING.
- RELOCATE FIRE ALARM CONTROL PANEL WHERE SHOWN ON PLANS. PATCH AND PAINT EXISTING PARTITION. MATCH EXISTING FINISHES.

- W5) REFERENCE MEP DRAWINGS FOR WORK @ EXISTING HOLD OPENS.

- DRAWINGS SHOW THE GENERAL EXTENT OF DEMOLITION WORK, HOWEVER IT IS IMPRACTICAL TO INDICATE OR NOTE EVERY ITEM OF DEMOLITION. ANY ITEMS SHOWN DASHED ARE TO BE REMOVED TO MAKE WAY FOR NEW CONSTRUCTION, UNLESS NOTED
- EXISTING MATERIALS CONTAINING ASBESTOS TO BE REMOVED UNDER SEPARATE CONTRACT PRIOR TO CONSTRUCTION BY OWNER'S ASBESTOS ABATEMENT CONTRACTOR.

GENERAL NOTES

- CONTRACTOR SHALL CONTACT THE OWNER PRIOR TO THE START OF DEMOLITION TO DETERMINE ITEMS TO BE SALVAGED AND RETURNED TO OWNER.
- CONTRACTOR SHALL PROTECT ITEMS TO REMAIN FROM DAMAGE DURING DEMOLITION 5. REFER TO FIRE ALARM DEMOLITION PLANS FOR ADDITIONAL INFORMATION.
- 6. CONTRACTOR SHALL REPAIR @ NO COST TO THE OWNER ANY DAMAGES THEY INCUR ON THE EXISTING BUILDING AND SITE AS A RESULT OF THEIR ACTIVITIES NOT SCHEDULED FOR
- 7. UNLESS OTHERWISE NOTED, NUMBERED NOTE 'W1' APPLIES TO ALL AREAS.





ORIENTATION PLAN - HIGH COUNTRY ELEMENTARY SCHOOL

SCALE: 1/16"=1'-0"

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PROJECT NO.


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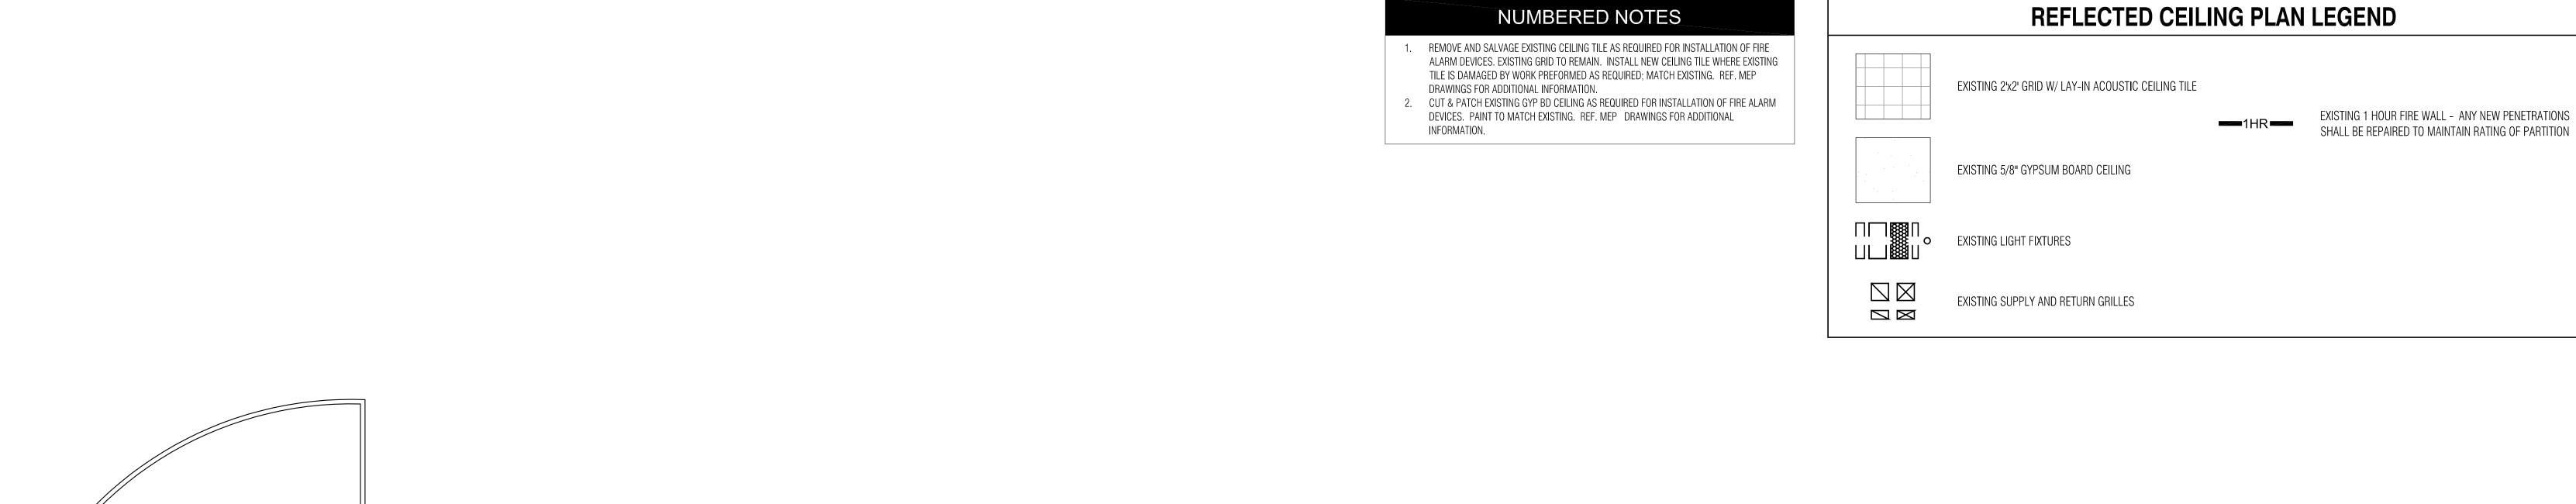
REFLECTED CEILING PLAN HIGH POINT ES

SHEET NO.

A2.61

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REFLECTED CEILING PLAN - HIGH COUNTRY ELEMENTARY SCHOOL

SCALE: 1/16"=1'-0"

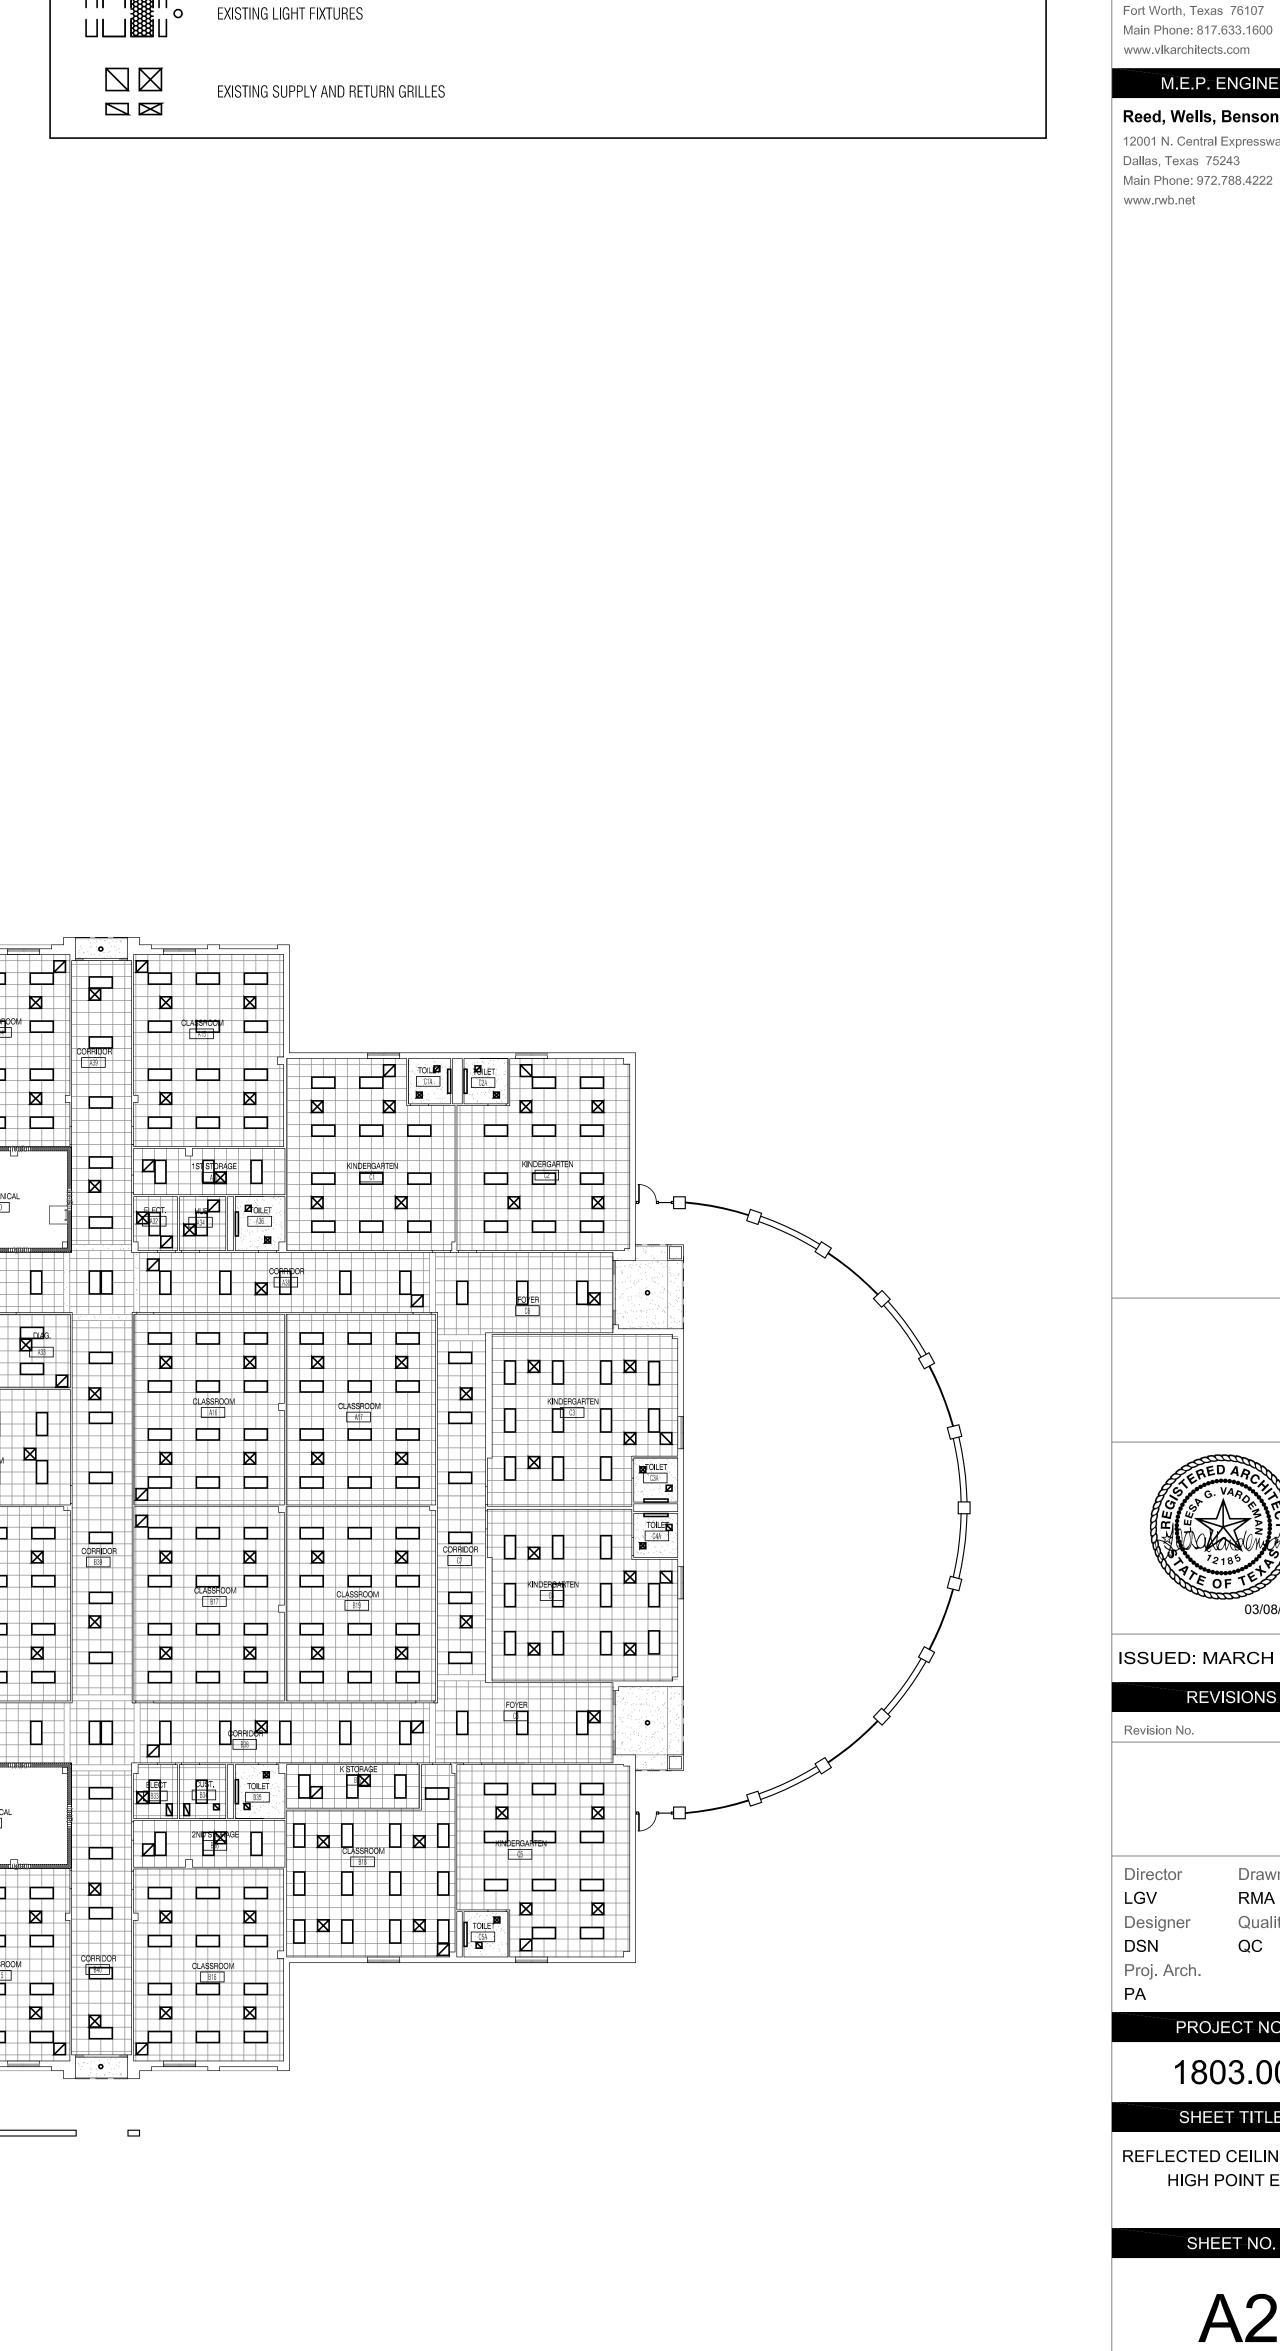MECHANICAL A19F

TYPICAL DUCT SCHEMATIC ONLY

F✓

FIELD VERIFY EXACT LOCATION — FOR OPTIMUM INSTALLATION.

FIRE ALARM NOTES BY SYMBOLS 'O':

- (1) EXISTING FIRE ALARM PANEL. DISCONNECT AND REMOVE UPON ACCEPTANCE AND CERTIFICATION OF NEW FIRE ALARM SYSTEM.
- (2) NEW FIRE ALARM REMOTE ANNUNCIATOR, VERIFY APPROVED LOCATION WITH LOCAL FIRE MARSHALL. (3) LOCATE NEW FIRE ALARM PANEL IN EXISTING MDF ROOM. PROVIDE NEW, 120V, 20 AMP CIRCUIT FOR NEW
- FIRE ALARM PANEL, EXTEND FROM EXISTING PANEL. PROVIDE NEW 20 AMP CIRCUIT BREAKER AS REQUIRED.
- (4) NEW FIRE ALARM DEVICE MOUNTED ON CEILING.
- (5) EXISTING DOOR HOLD DEVICE, EXTEND TO NEW FIRE ALARM SYSTEM TO RELEASE ON ALARM. (6) CONNECT NEW FIRE ALARM SYSTEM, TO EXISTING KITCHEN HOOD FIRE SUPPRESSION SYSTEM, FOR ALARM

ALL SCOPE REQUIRED FOR CONNECTION TO EXISTING UNIT FAN CONTROL RELAY. COORDINATE LOCATION

FIELD VERIFY EXACT LOCATION —

CLASSROOM 605

F⊲

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FOR OPTIMUM INSTALLATION.

AND INSTALLATION REQUIREMENTS WITH DISTRICT, HVAC, AND ENERGY MANAGEMENT DEPARTMENTS.

F✓

CLASSROOM 602

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F✓

F✓

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- ON ACTIVATION. (7) PROVIDE NEW DUCT MOUNTED SMOKE DETECTOR AT EXISTING HVAC DUCT FOR FAN SHUT-DOWN. INCLUDE
- FOLLOW RECOMMENDED INSTALLATION INSTRUCTIONS FROM THE MANUFACTURER. REFER TO DETAIL 02. (8) EXISTING PA SYSTEM RACK, PROVIDE INTEGRATED CONNECTION TO MUTE EXISTING PA SYSTEM OUTPUT,
- ON FIRE ALARM. (9) PROVIDE OPEN-AREA SMOKE IMAGING DETECTORS (OSID) IN THIS AREA. SYSTEM TO BE XTRALIS OSID. PROVIDE EMITTER LOCATION AND QUANTITY AS REQUIRED FOR COVERAGE IN THIS SPACE. PROVIDE MANUFACTURER'S WIRE-GUARD FOR ALL DEVICES.

GENERAL FIRE ALARM NOTES:

- 1. BUILDING PLAN IS DIAGRAMMATIC ONLY, SOME DIFFERENCES OCCUR BETWEEN PLANS AND ACTUAL BUILDING, CONTRACTOR TO FAMILIARIZE HIMSELF WITH BUILDING, AND VERIFY ACTUAL LAY-OUT.
- 2. ALL EXISTING PA, TELEPHONE, POWER AND OTHER WIRING ABOVE EXISTING LAY-IN CEILING AND HARD CEILINGS SHALL BE MAINTAINED IN OPERATION AT ALL TIMES. CONTRACTOR IS RESPONSIBLE FOR
- RECONNECTING ANY SERVICES DISRUPTED AT NO ADDITIONAL COST TO OWNER. 3. ALL ELECTRICAL WORK, NEW CIRCUITS, ECT. REQUIRED TO FACILITATE NEW FIRE ALARM SYSTEM SHALL
- BE PROVIDED BY CONTRACTOR. 4. EXISTING FIRE ALARM SYSTEM MUST BE KEPT IN OPERATION, UNTIL THE NEW FIRE ALARM SYSTEM IS
- ACCEPTED BY THE LOCAL AUTHORITY AND GREEN TAG IS AWARDED.
- 5. MAINTAIN MINIMUM 36" CLEAR FROM ALL AIR DISTRIBUTION DEVICES.

6. DEVICE LOCATIONS SHOWN ARE APPROXIMATE; ADJUST DEVICE LOCATIONS TO ACCOMMODATE EXISTING

- CEILING ELEMENTS, HVAC GRILLES, LIGHT FIXTURES OR OTHER BLDG. ELEMENTS. 7. PROTECT ALL DEVICES DURING INSTALLATION FROM DUST AND DEBRIS.
- 8. PROTECT ALL EXISTING PA, AND SECURITY SYSTEM DEVICES DURING INSTALLATION FROM DUST AND
- 9. REMOVE ALL ABANDONED DEVICES / PANELS / EQUIPMENT THRU OUT FACILITY. PATCH AND PAINT ALL EXISTING WALL OPENINGS AND OPENINGS IN GYPSUM/HARD CEILINGS AS DIRECTED BY ARCHITECT.
- 10. FIRE ALARM CONTRACTOR TO FIELD VERIFY EXISTING HVAC FOR REQUIRED DUCT SMOKE DETECTION. 11. ALL WIRING LOCATED IN GYMS, MECHANICAL ROOMS, ELECTRICAL ROOMS, AND OTHER LOCATIONS WHERE
- SUBJECT TO DAMAGE SHALL BE INSTALLED IN A METALLIC RACEWAY SYSTEM. 12. WHERE WIRING IS TO BE INSTALLED ON EXISTING MASONRY WALLS, PROVIDE A SURFACE MOUNTED
- RACEWAY SYSTEM EQUAL TO WIREMOLD 2000 SERIES, AND INCLUDE ALL REQUIRED COMPONENTS FOR A COMPLETE SYSTEM REQUIRED FOR ROUTING TO A CONCEALED LOCATION.
- 13. PROVIDE CEILING NOTIFICATION DEVICES WHERE POSSIBLE.

SIGNALING.

F⊲

SCIENCE LAB

F⊲

TYPICAL

14. PROVIDE CLASS A WIRING FOR BOTH INITIATION AND NOTIFIC ATION CIRCUITS. REFER TO SPECIFICATIONS

	FOR	ADDI1	IONAL	INFORMA	TION.	_						_			
15.	NEW	FIRE	ALARM	SYSTEM	SHALL	BE	EQUIPPED	WITH	VOICE	EVACUATION	FOR	THE	AUDIBLE	NOTIFIC	A TION

SPECIA	L SYSTEMS LEGEND
F	FIRE ALARM MANUAL PULL STATION
F	FIRE ALARM SPEAKER/STROBE ASSEMBLY
S	FIRE ALARM STROBE ASSEMBLY
<u>\$</u>	CEILING MOUNTED SMOKE DETECTOR
<u>(\$)</u>	DUCT MOUNTED SMOKE DETECTOR
\bigoplus	CEILING MOUNT HEAT DETECTOR
FACP	FIRE ALARM CONTROL PANEL
FAA	FIRE ALARM ANNUNCIATOR PANEL
PA	PA SYSTEM RACK
DH	FIRE ALARM DOOR HOLD OPEN DEVICE

NOT ALL SYMBOLS USED

EQUIPMENT STORAGE ! 7

-EXISTING KITCHEN HOOD FIRE

SUPPRESSION SYSTEM

F⊲



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ISSUED: MARCH 8, 2018

REVISIONS

Revision No.


Drawn By Director

Designer DSN

1803.00

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FA1.01

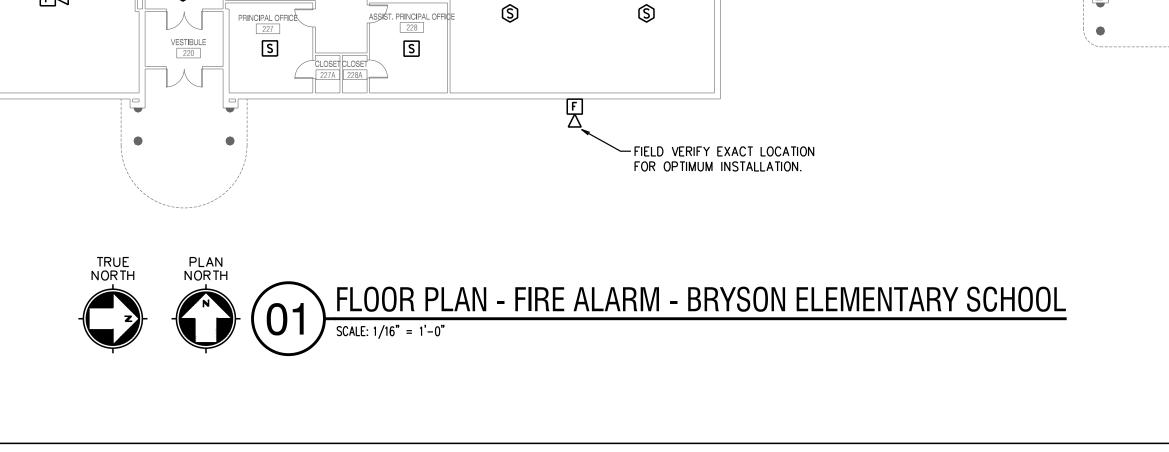

GENERAL FIRE ALARM NOTES:

- 1. BUILDING PLAN IS DIAGRAMMATIC ONLY, SOME DIFFERENCES OCCUR BETWEEN PLANS AND ACTUAL BUILDING, CONTRACTOR TO FAMILIARIZE HIMSELF WITH BUILDING, AND VERIFY ACTUAL LAY-OUT.
- 2. ALL EXISTING PA, TELEPHONE, POWER AND OTHER WIRING ABOVE EXISTING LAY-IN CEILING AND HARD CEILINGS SHALL BE MAINTAINED IN OPERATION AT ALL TIMES. CONTRACTOR IS RESPONSIBLE FOR
- RECONNECTING ANY SERVICES DISRUPTED AT NO ADDITIONAL COST TO OWNER. 3. ALL ELECTRICAL WORK, NEW CIRCUITS, ECT. REQUIRED TO FACILITATE NEW FIRE ALARM SYSTEM SHALL
- BE PROVIDED BY CONTRACTOR. 4. EXISTING FIRE ALARM SYSTEM MUST BE KEPT IN OPERATION, UNTIL THE NEW FIRE ALARM SYSTEM IS

SPECIAL SYSTEMS LEGEND					
F	FIRE ALARM MANUAL PULL STATION				
F	FIRE ALARM SPEAKER/STROBE ASSEMBLY				
S	FIRE ALARM STROBE ASSEMBLY				
⊘	CEILING MOUNTED SMOKE DETECTOR				
\$	DUCT MOUNTED SMOKE DETECTOR				
$\langle \Xi \rangle$	CEILING MOUNT HEAT DETECTOR				
FACP	FIRE ALARM CONTROL PANEL				
FAA	FIRE ALARM ANNUNCIATOR PANEL				
РА	PA SYSTEM RACK				
DH	FIRE ALARM DOOR HOLD OPEN DEVICE				
ALL SYMBO	LS USED				

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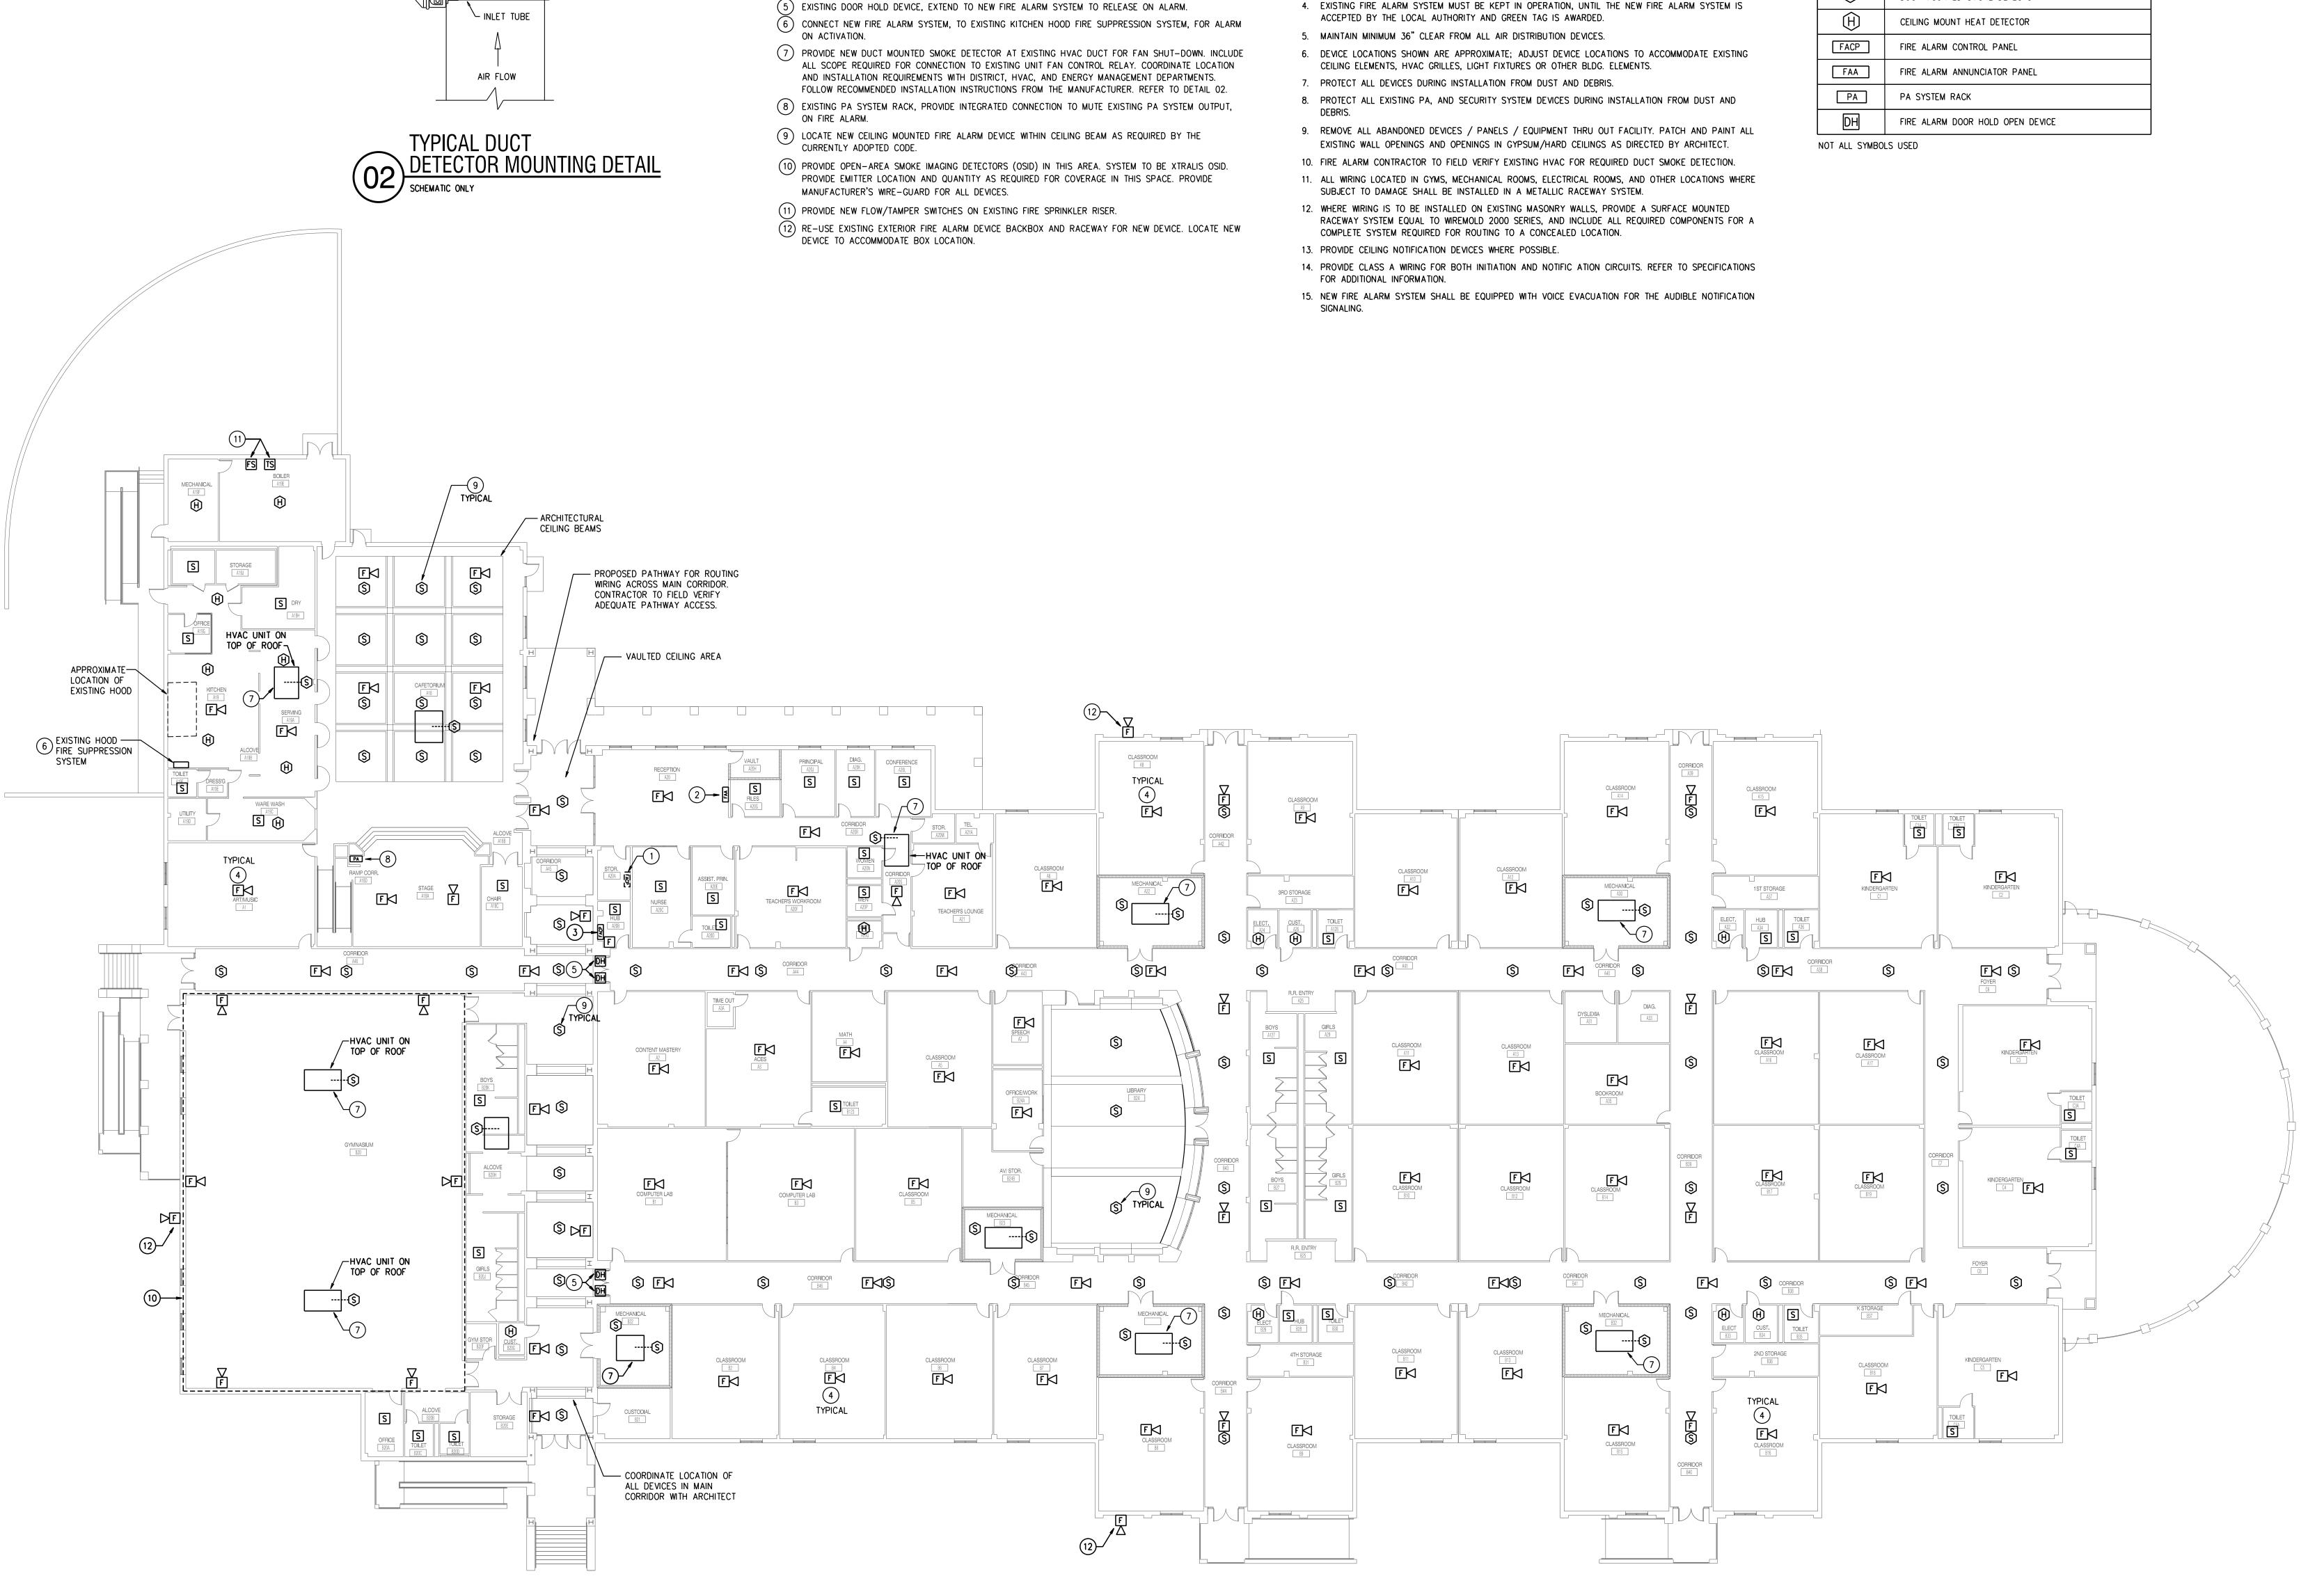
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LGV Designer DSN Proj. Arch.

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FIRE ALARM NOTES BY SYMBOLS 'O':

FIRE ALARM SYSTEM.

(4) NEW FIRE ALARM DEVICE MOUNTED ON CEILING.

ANY TUBE OVER 3'-0" LONG MUST BE SUPPORTED ON OPPOSITE SIDE FROM

HOUSING.

-EXHAUST

- TUBE END PLUG

CONDUIT/FLEX INPUT CONNECTION —

(SLC LOOP) FROM F.A.C.P. BY FIRE

ÀLARM SYŚTEM INSTALLER.

AND INSTALLED BY FIRE

ON EXISTING DUCT.

ALARM SYSTEM INSTALLER

DUCT DETECTOR FURNISHED -

1) EXISTING FIRE ALARM PANEL. DISCONNECT AND REMOVE UPON ACCEPTANCE AND CERTIFICATION OF NEW

(3) LOCATE NEW FIRE ALARM PANEL IN EXISTING MDF ROOM. PROVIDE NEW, 120V, 20 AMP CIRCUIT FOR NEW

FIRE ALARM PANEL, EXTEND FROM EXISTING PANEL. PROVIDE NEW 20 AMP CIRCUIT BREAKER AS

(2) NEW FIRE ALARM REMOTE ANNUNCIATOR, VERIFY APPROVED LOCATION WITH LOCAL FIRE MARSHALL.